

### 3 SHEARWALL SCHEDULE


TYPE	
1	1/2" C-D SHEATHING W/ 8d AT 6" O.C. AT EDGES & 12" O.C. IN FIELD
2	5/8" C-D SHEATHING W/ 10d AT 3" O.C. AT EDGES & 12" O.C. IN FIELD
3	5/8" C-D SHEATHING W/ 10d AT 2" O.C. AT EDGES & 12" O.C. IN FIELD

### GENERAL NOTES

- A. ALL BOTTOM OF FOOTING ELEVATIONS TO BE 93'-0" U.N.O.
- B. 4" CONCRETE SLAB-ON-GRADE W/ #3 AT 18" O.C. EACH WAY CENTERED IN SLAB, RE: S3.1-1 FOR TYPICAL S.O.G. SECTION.
- C. CONTROL JOINTS/CONSTRUCTION JOINTS LOCATIONS IN SLAB-ON-GRADE, APPROX. LOCATIONS SHOWN ON PLAN, LOCATE PER THE FOLLOWING GUIDELINES:
1. MAX LENGTH BETWEEN ANY CONTROL JOINT TO BE 15'-0" [4572mm]
  2. MAX AREA OF CONCRETE SLAB ENCOMPASSED BY CONTROL JOINTS IS TO BE 225 SQUARE FEET
  3. MAX ASPECT RATIO SHALL BE 1.5 TO 1.0
  4. LOCATE IN AT LEAST ONE DIRECTION FROM ALL RE-ENTRANT CORNERS.
- D. STEP FOOTING PER DETAIL S3.1-3.
- E. FINISHED FIRST FLOOR ASSUMED TO BE AT 100'-0".
- F. DRILL & EPOXY #5 REBAR TO MATCH HORIZ. FOOTING REINFORCING LOCATIONS FROM NEW FOOTINGS INTO (E) FOOTINGS.
- G. HEADER CONNECTION PER S3.1-16.
- H. SEE ARCHITECTURAL DRAWINGS FOR ALL FINAL DIMENSIONS.

### # SHEET NOTES:


1. (E) PORCH FRAMING.
2. REBUILD STAIRS IN CONCRETE PER DETAIL.
3. (N) CONC RAMP AND WALLS, CW/ CIVIL.
4. (N) CONCRETE STAIRS.
5. (E) FLOOR FRAMING.
6. (N) 2X6 STUDS @ 16" O.C. ON (E) FDN.
7. (E) FLOOR JOISTS.
8. (N) CONCRETE RETAINING WALL @ MECH. WELL.
9. HSS6X6X1/4, RE: S3.2-6.
10. 2'-6"x2'-6"x1'-0" PAD FTG. W/ (3) #5 AT 12" O.C., EA. WAY
11. 2'-9"x2'-9"x1'-0" PAD FTG. W/ (4) #5 AT 12" O.C., EA. WAY
12. 3'-3"x3'-3"x1'-0" PAD FTG. W/ (4) #5 AT 12" O.C., EA. WAY
13. 4'-0"x4'-0"x1'-0" PAD FTG. W/ (5) #5 AT 12" O.C., EA. WAY
14. 4'-9"x4'-9"x1'-0" PAD FTG. W/ (6) #5 AT 12" O.C., EA. WAY
15. 12" SLAB W/ #5 AT 12" O.C., EA. WAY
16. SLAB-ON-GRADE
17. THICKENED SLAB AT STAIR STRINGER LANDING, RE: S3.1-6
18. DRILL & EPOXY REINFORCING IN (N) FOOTINGS TO (E) FOOTINGS.

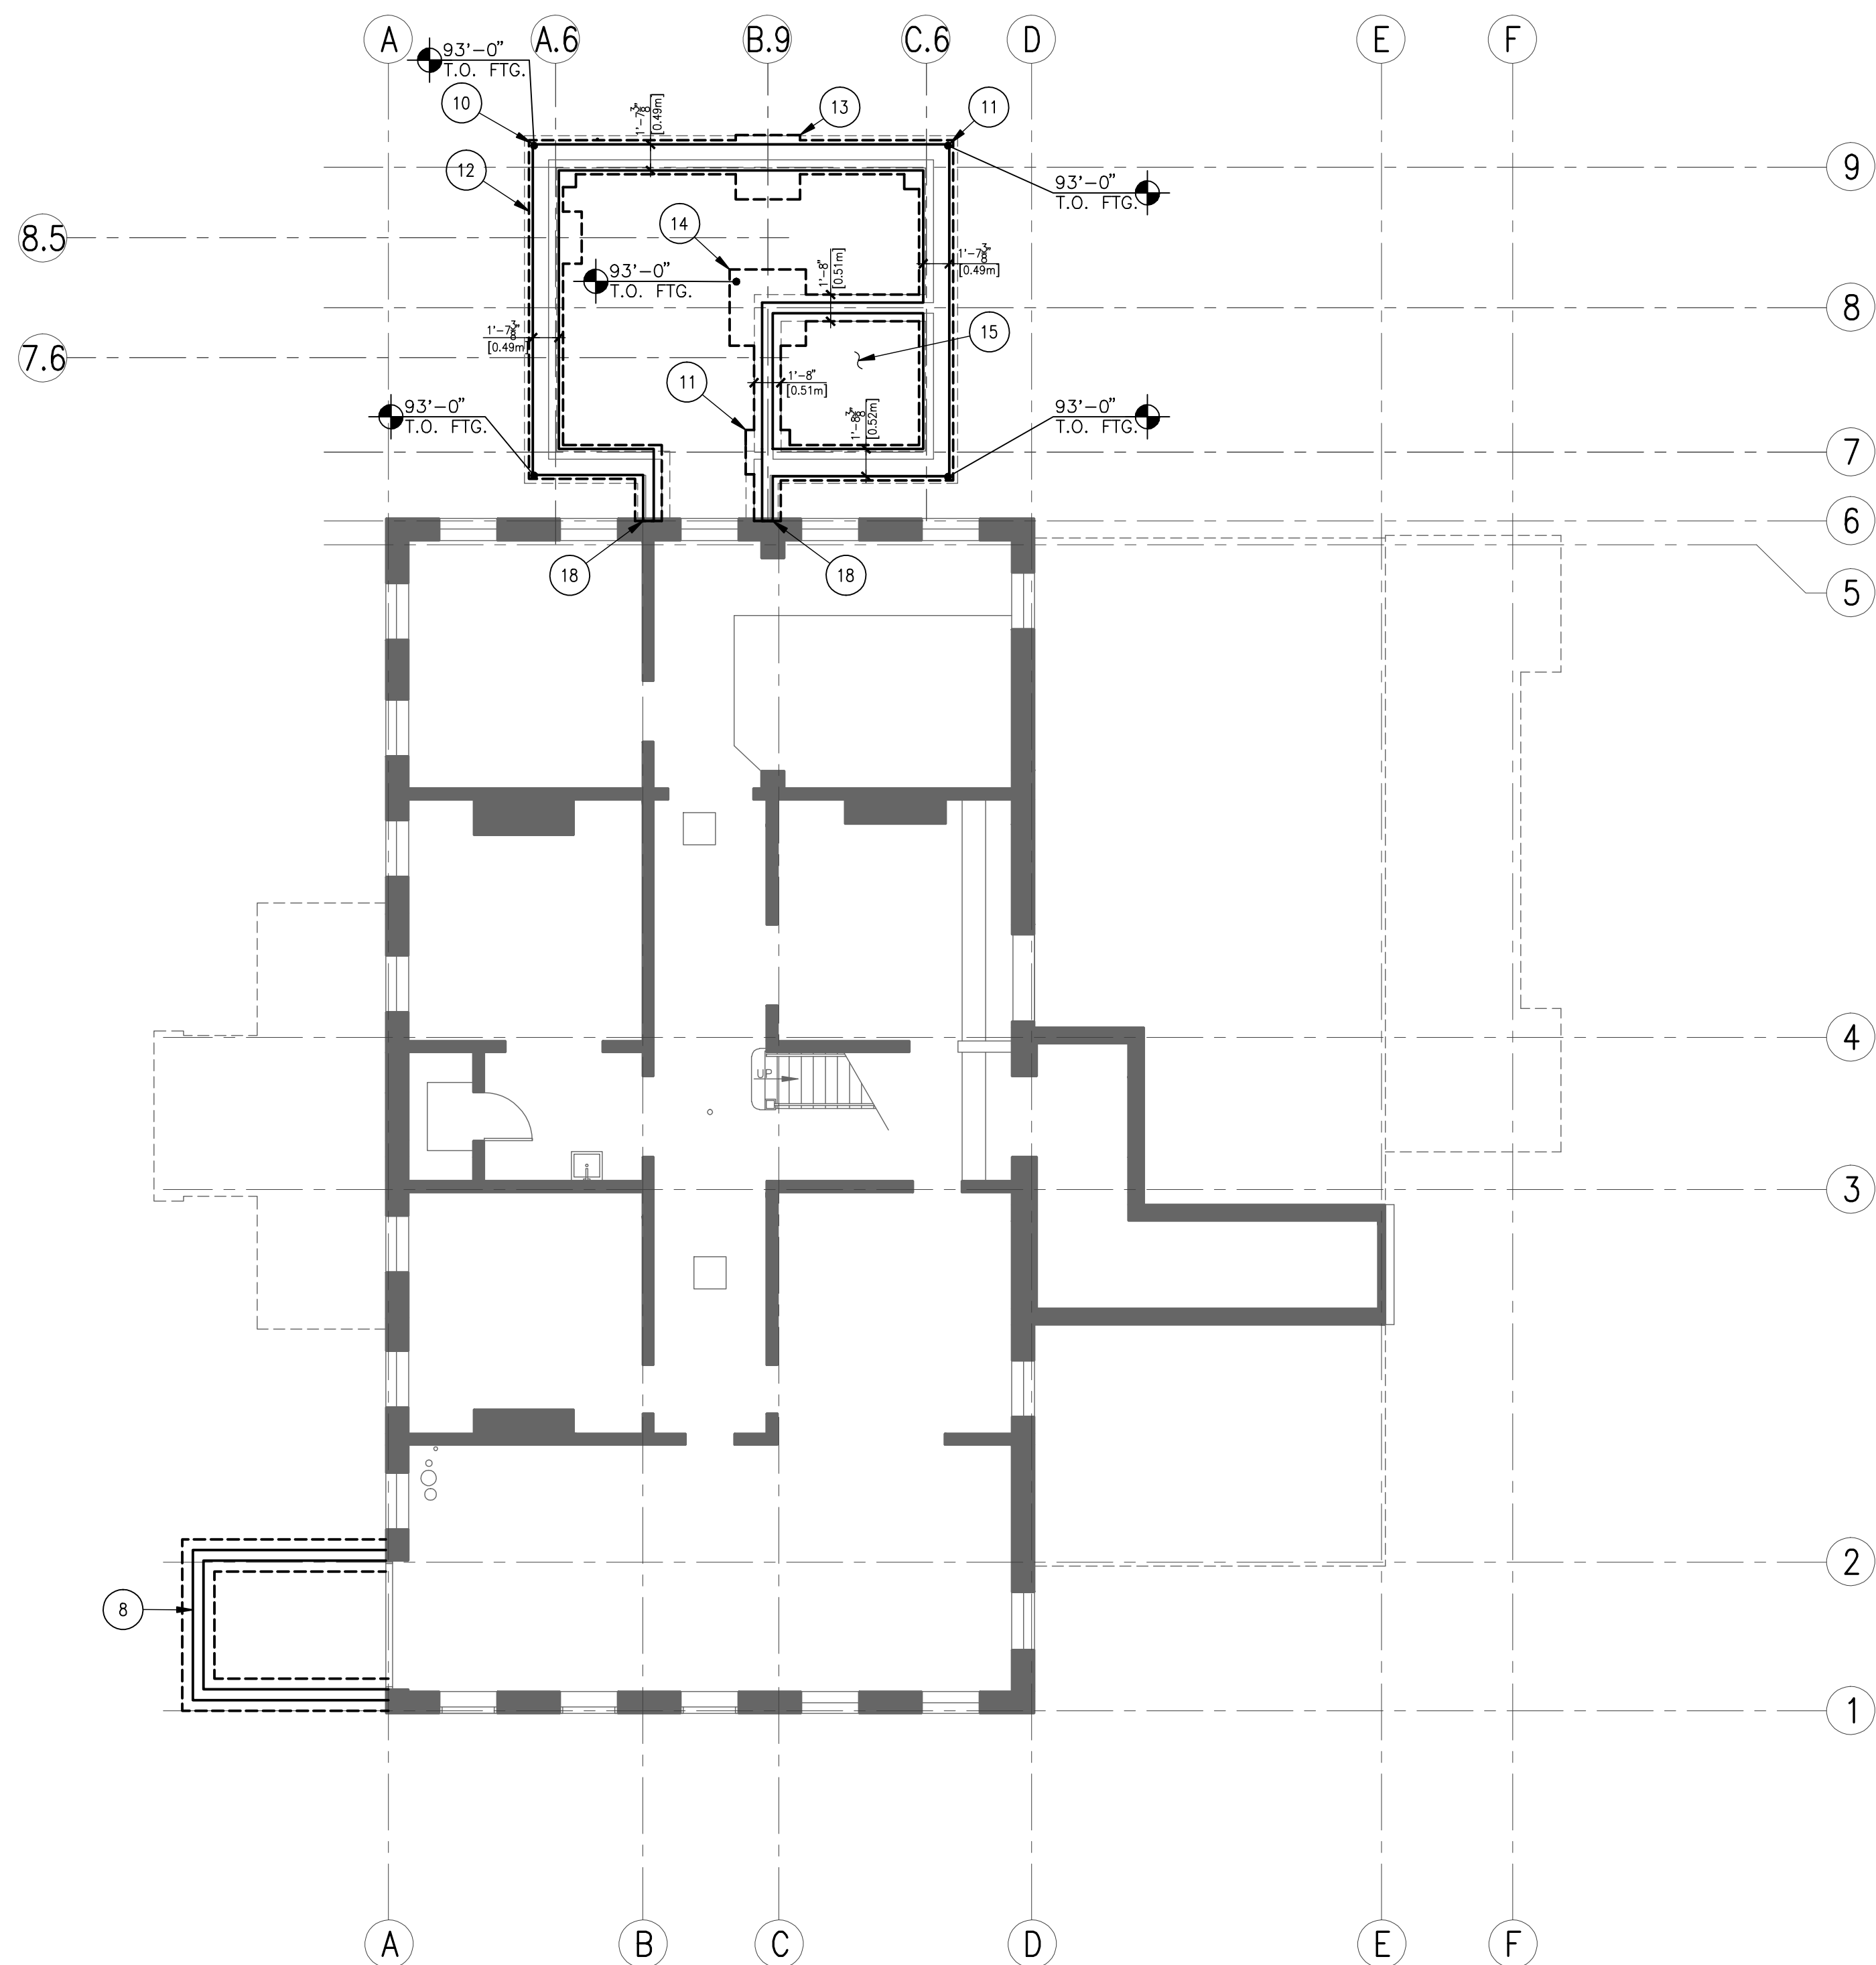

1 (E) FOUNDATION PLAN BLDG. 33

0' 4' 8' 12' 16' 20'

SCALE: 1/8" = 1'-0"

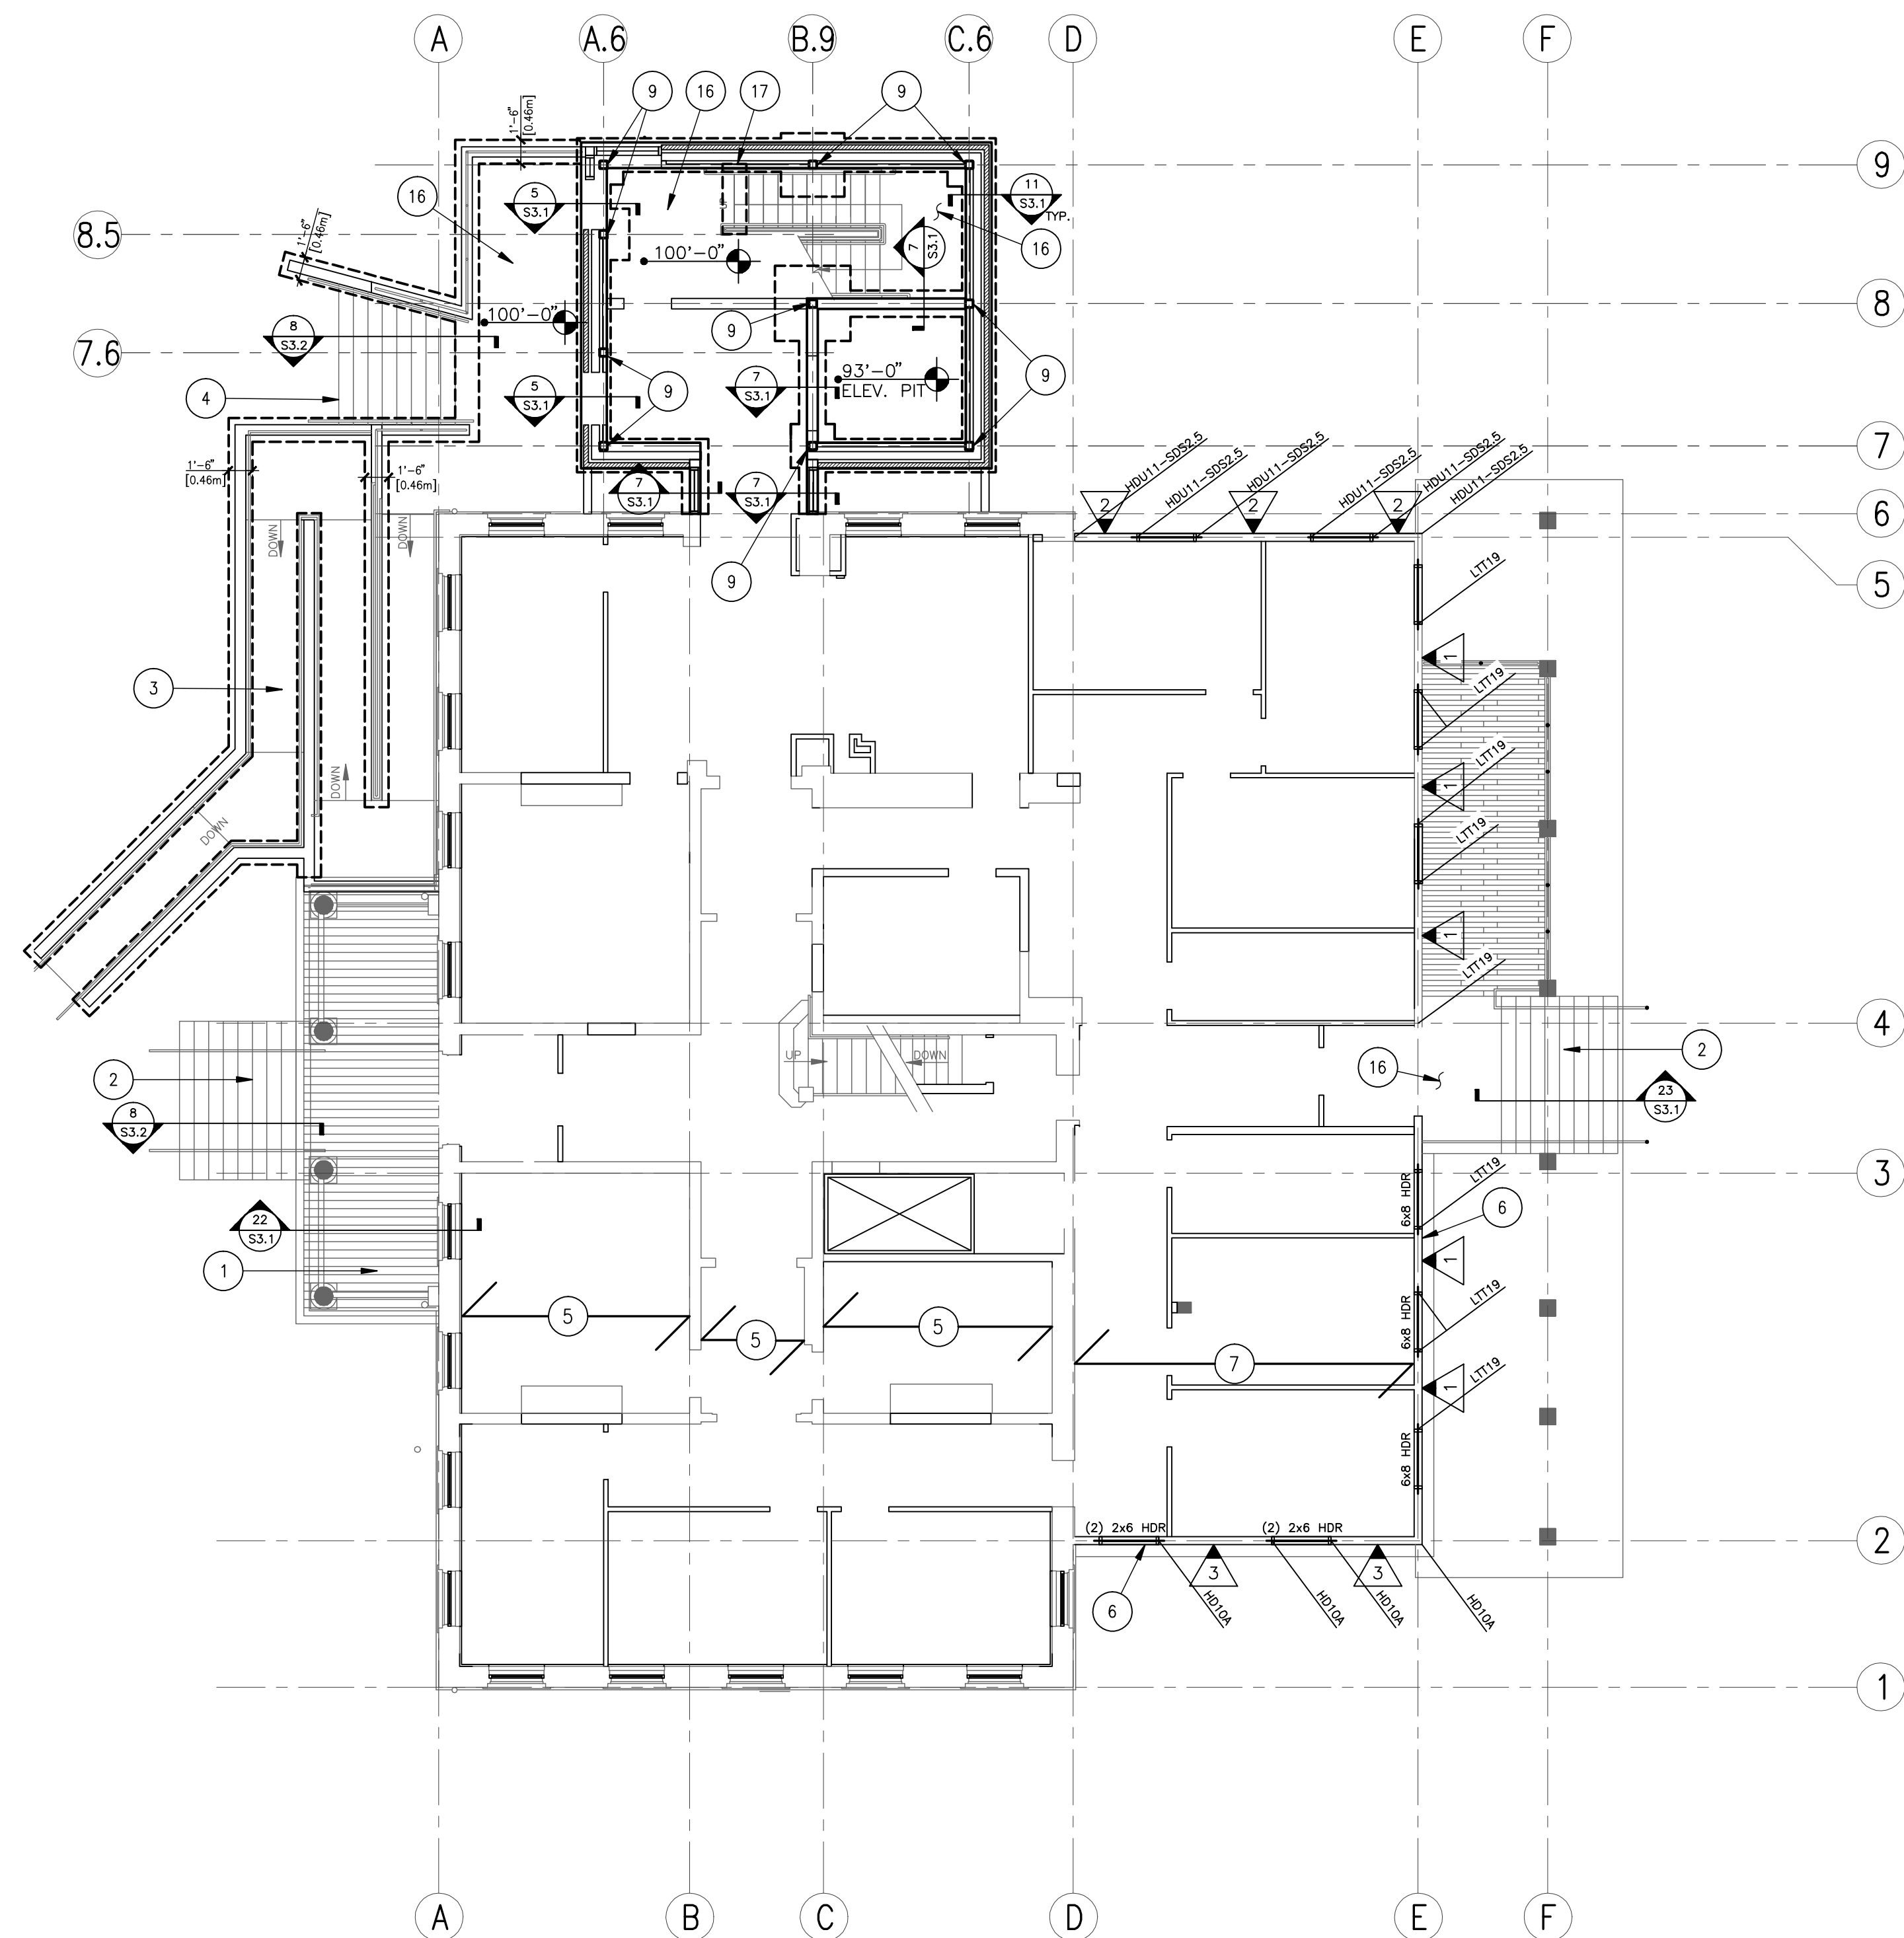

2 FIRST FLOOR FRAMING PLAN BLDG. 33

0' 4' 8' 12' 16' 20' 24'

SCALE: 1/8" = 1'-0"

95% SUBMISSION

**CSHQ**

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PRELIMINARY  
NOT FOR  
CONSTRUCTION

FOUNDATION PLAN/  
FIRST FLOOR FRAMING PLAN

APPROVED: DIVISION CHIEF

APPROVED: SERVICE DIRECTOR

PROJECT TITLE  
VAMC  
RENOVATE  
BUILDING 33

BUILDING NUMBER  
33

LOCATION  
BOISE, IDAHO

CHECKED  
BA


DRAWN  
MG

DATE  
03/04/11

PROJECT NO.  
531-10-114

DRAWING NO.  
S2.1

DWG. 49 OF 102

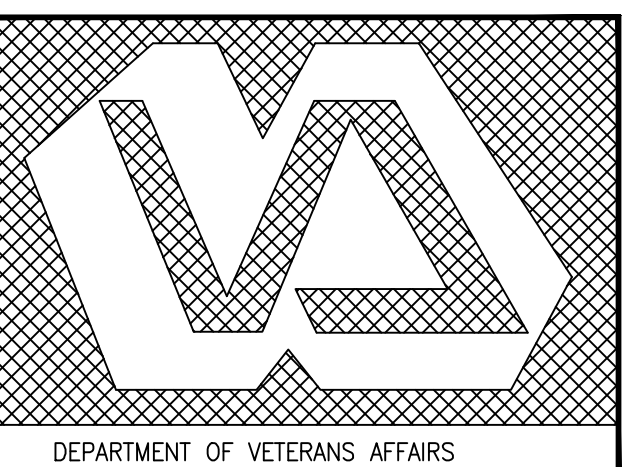

DEPARTMENT OF VETERANS AFFAIRS